


FIXTURE SCHEDULE						
SYM.	DESCRIPTION	НОТ	COLD	WASTE	VENT	
(DW-I)	<u>DISH WASHER</u> - JACKSON VENTLESS MODEL TEMPSTART HH-E PLUMBER TO ROUGH IN, CONNECT COLD WATER, AND CONNECT DRAIN TO FLOOR SINK.		3/4"	I-I/2"		
(5-I)	CORNER SINK - JOHN BOOS MODEL 3PBCSI620-2DI8. I2" DEEP BOWL STAINLESS STEEL I6GA. I4-8I4L KROWNE ROYAL FAUCET. PLUMBER TO ROUGH IN, CONNECT CM & HW, AND CONNECT DRAIN TO GREASE TRAP.	1/2"	1/2"	TO GT-I	I-I/2"	
(5-2)	SOILED SINK - JOHN BOOS MODEL JDTS-20-60L-X DISHTABLE FOR LEFT-TO RIGHT OPERATION. KROWNE MODEL 17-108WL ROYAL SERIES FAUCET. PLUMBER TO ROUGH IN, CONNECT CW & HW, AND PROVIDE & INSTALL DISPOSAL.	1/2"	1/2"	I-I/2"	I-I/2"	
(5-3)	PREP SINK - JOHN BOOS MODEL EIS8-1620-12L18-X DISHTABLE. KROWNE MODEL 14-812L ROYAL SERIES FAUCET. PLUMBER TO ROUGH IN, CONNECT COLD WATER, AND CONNECT DRAIN TO FLOOR SINK.	1/2"	1/2"	I-I/2"	I-I/2"	
5-4	WALL HUNG HAND WASH SINK - KROWNE METAL MODEL HS-2L 16 WIDE HAND SINK. 4" OC SPLASH MOUNT GOOSENECK FAUCET. PLUMBER TO ROUGH IN, CONNECT COLD WATER, CONNECT DRAIN TO FLOOR SINK. WITH I/2" BALL STOPS, AND I-I/2" CHROME P-TRAP.	1/2"	1/2"	I-I/2"	I-I/2"	
F5-I)	FLOOR SINK - ZURN Z-1900-KC WITH WHITE ENAMEL FINISH, DOME STRAINER AND 4" DEEP SEAL P-TRAP. PROVIDE 3/4 GRATE OVER SINK.			4"	2"	
L-I	ADA COUNTERTOP LAVATORY - EXISTING LAVATORY TO REMAIN REPLACE WITH MOEN L4601 LEVER FAUCET, MIXING VALVE, K-7715. PROVIDE INSULATING JACKET ON HW & DRAIN UNDER LAVATORY.	1/2"	1/2"	I-I/2"	I-I/2"	
GT-I)	GREASE TRAP - ZURN ZIITO (SIZE 600) 50#, I5 GPM FLOW FLOOR MOUNTED GREASE TRAP. PROVIDE TRAP WITH ZIIO8 FLOW CONTROL FITTING. INTERCEPTOR LID TO BE ACCESSIBLE FOR GREASE REMOVAL.			3"	2"	
JS-I)	FLOOR MOUNTED SERVICE SINK - KOHLER K-6710 "WHITBY" W/ K-8940 WIRE RIM GUARD, K-8928 FAUCET ASSEMBLY AND K-9142 STRAINER WITH DEEP SEAL P-TRAP.	1/2"	1/2"	2"	2"	
FD-I)	2" FLOOR DRAIN - ZURN Z-415 WITH 5"Φ NICKEL-BRONZE STRAINER AND 2" DEEP SEAL P-TRAP.PROVIDE WITH TRAP PRIMER EXCEPT AT SHOWERS.			2"	2"	

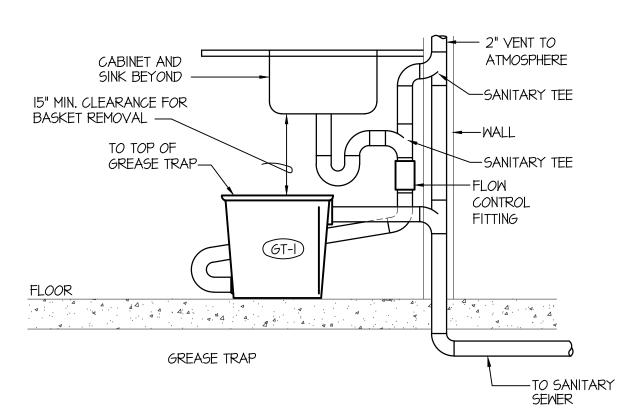


EXPOSED GREASE TRAP DETAIL NO SCALE

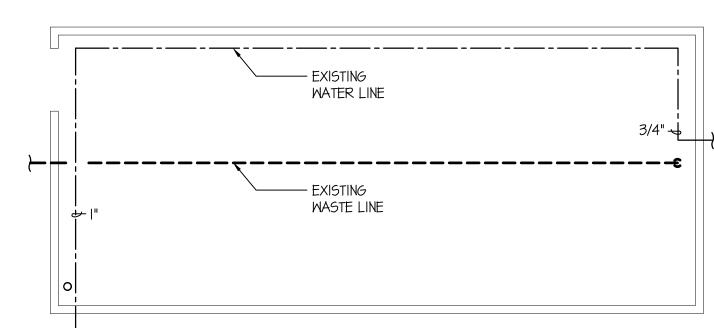

PLUMBING BASEMENT FLOOR PLAN SCALE: 1/8" = 1'-0"

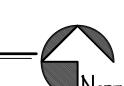

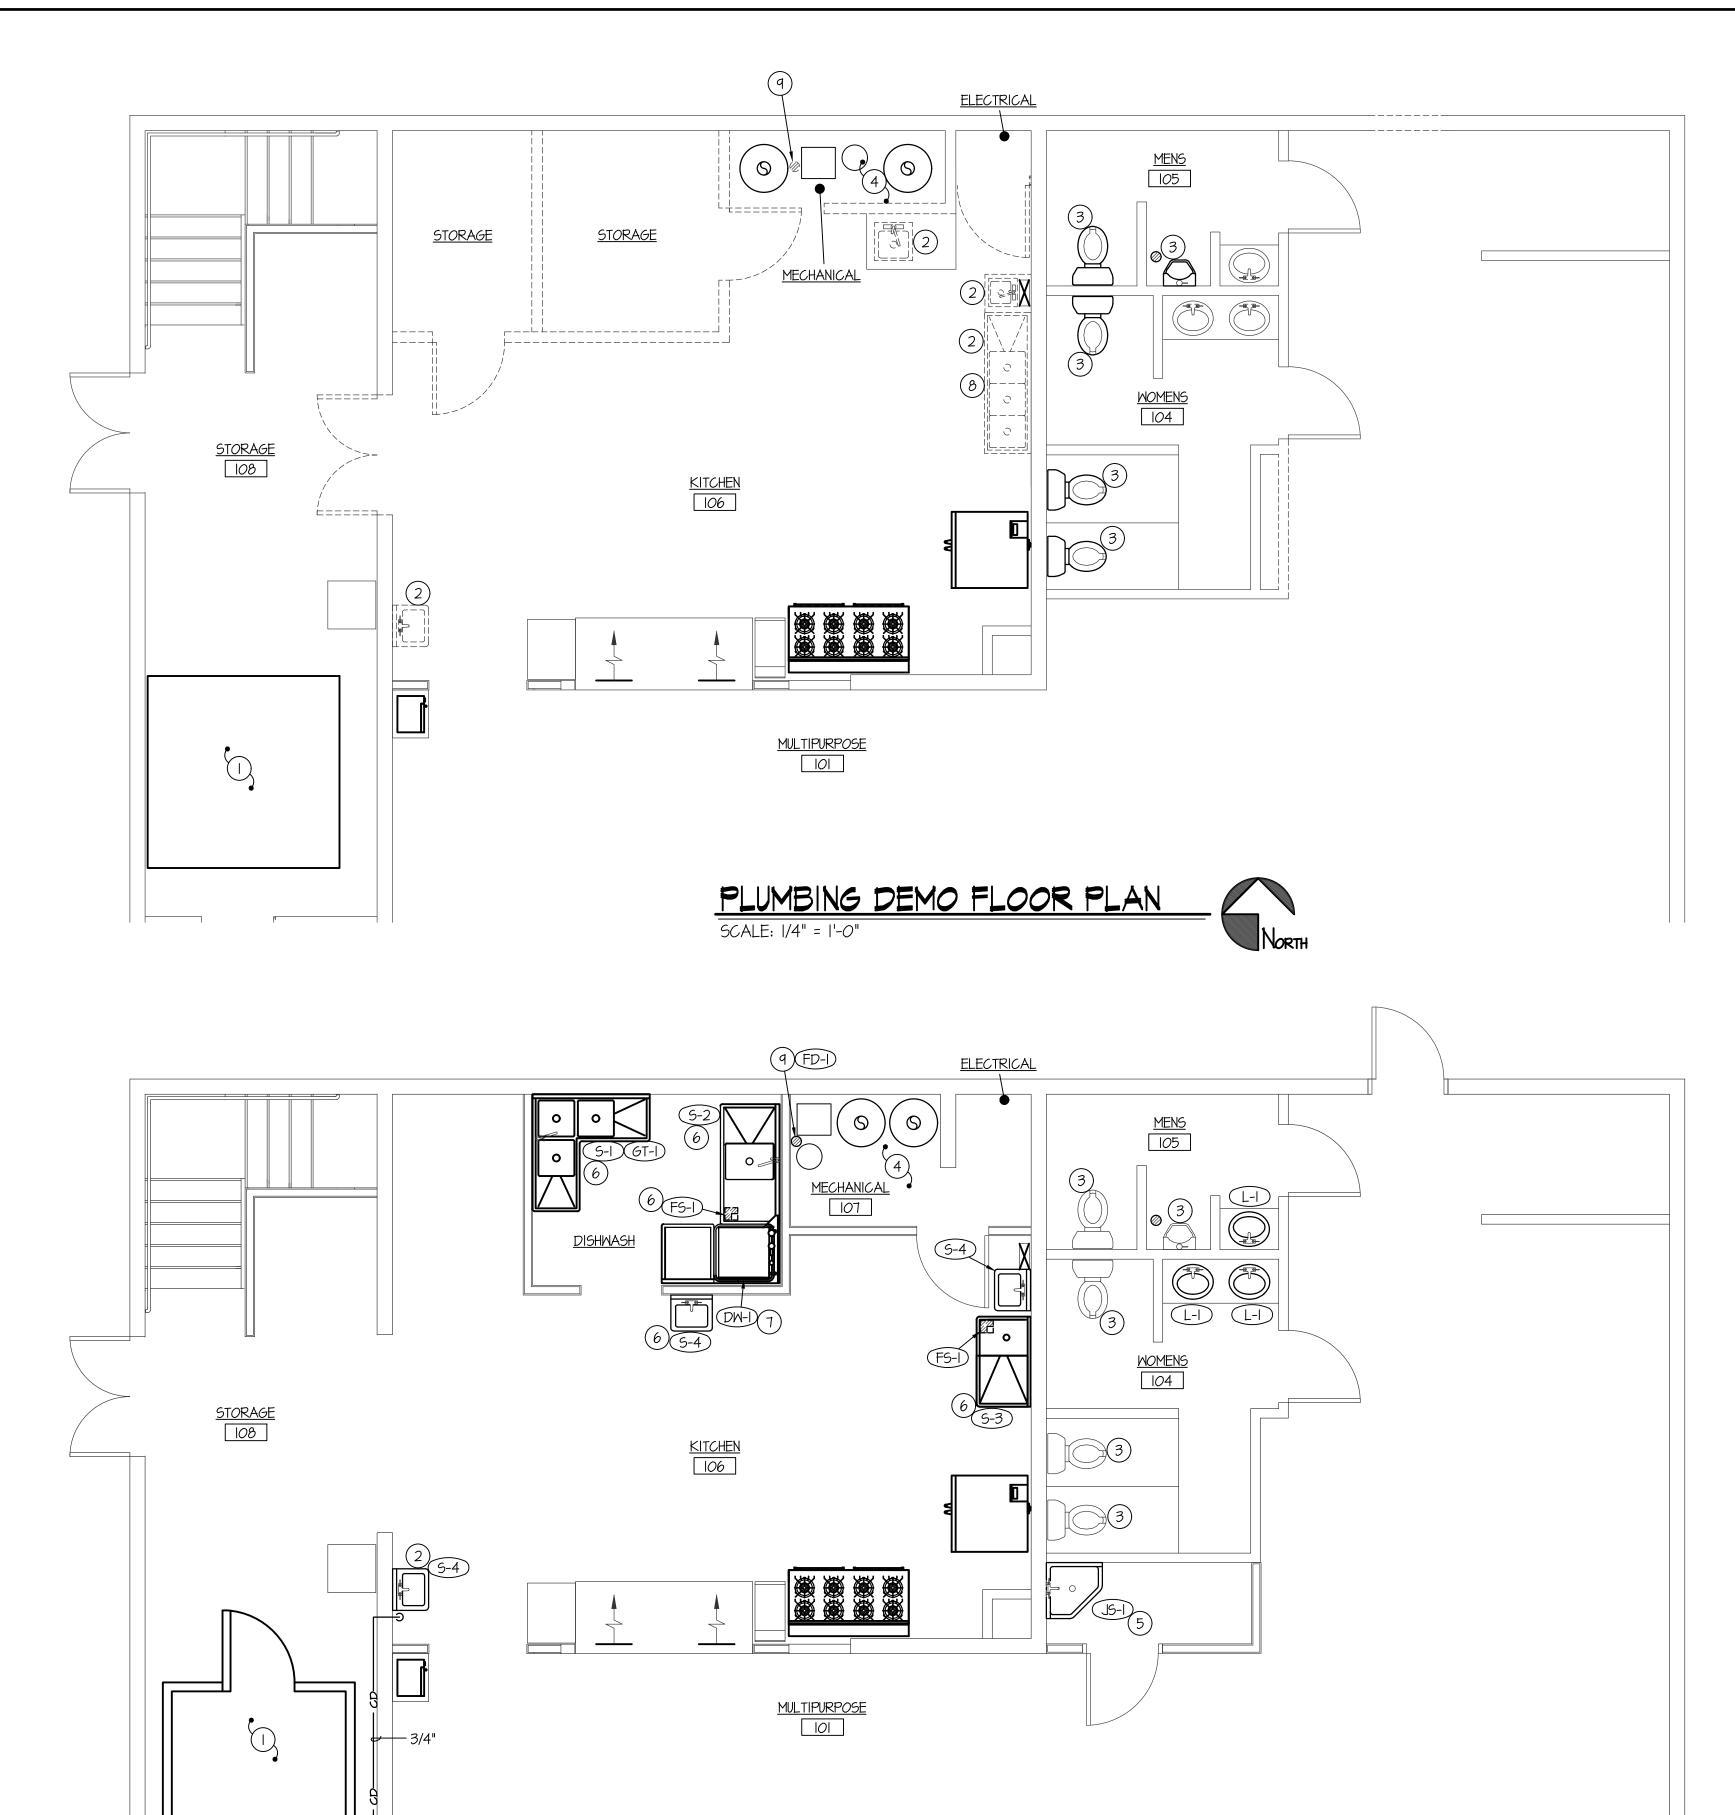

PLUMBING FLOOR PLAN

SCALE: 1/4" = 1'-0"

PLAN NOTES:

-) EXISTING FREEZER TO BE REPLACED. INSTALL NEW 3/4" CONDENSATE LINE FROM FREEZER ACROSS CEILING AS HIGH AS POSSIBLE. DROP DOWN AND CONNECT TO EXISTING 3/4" OR LARGER CONDENSATE LINE. FIELD VERIFY EXACT LOCATION. CONTRACTOR TO INSULATE CONDENSATE LINE LOCATED IN FREEZER AND PROVIDE HEAT TRACE AS REQUIRED. CAP AND ABANDON IF NOT REQUIRED.
- 2) DISCONNECT AND DISPOSE OF EXISTING FIXTURE. CAP UN-USED WASTE, WATER AND VENT IN WALL OR UNDER FLOOR AS REQUIRED.
- (3) EXISTING TOILET, AND URINAL REMAIN PROTECT DURING CONSTRUCTION.
- (4) REMOVE EXISTING WATER HEATERS AND WATER SOFTENER SYSTEM DURING NEW FLOOR FINISH AND RELOCATE TO NEW LOCATION AS SHOWN. MODIFY VENT, WATER AND GAS LINES AS REQUIRED FOR NEW LOCATIONS. ROUTE WATER HEATERS PRV LINES TO NEW FLOOR DRAIN UNDER DW-1. FIELD VERIFY EXISTING HW & CW ROUTES AND SIZES.
- 5) PROVIDE AND INSTALL NEW JANITOR SINK IN LOCATION AS SHOWN. RUN WASTE, WATER AND VENT FROM NEAREST EXISTING LINES. CW & HW 1/2" LINE TO BE BRANCHED OFF FROM NEAREST 3/4" OR LARGER.

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SCHEDULES

DETAILS,

FLOOR PLAN

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- (6) PROVIDE AND INSTALL NEW FIXTURE AS SHOWN. 1/2" HOT AND COLD WATER LINE TO BE BRANCHED OFF NEAREST 3/4" OR GREATER, ROUTE NEW WASTE & VENT TO EXISTING AS REQUIRED. FIELD VERIFY EXISTING WASTE & VENT ROUTE AND ELEVATIONS. EXHAUST HOOD TO REMAIN, PROTECT DURING CONSTRUCTION.
- 7) RUN 3/4" COLD WATER LINE TO DISH WASHER AS PER MANUFACTURE REQUIREMENTS. RUN 1-1/2" WASTE TO NEW FLOOR DRAIN FOR A INDIRECT CONNECTION TO
- (8) REMOVE AND DISPOSE OF EXISTING GREASE TRAP.
- (9) REMOVE EXISTING FLOOR DRAIN FOR NEW FLOOR FINISH. SHIFT LOCATION AS REQUIRED TO CLEAR NEW WALL AND REPLACE WITH NEW.

PLUMB	ING LEGEND			
SYMBOL	DESCRIPTION			
V	VENT			
VTR	VENT THRU ROOF			
CO	CLEANOUT			
MCO	WALL CLEANOUT			
COTG	CLEANOUT TO GRADE			
e	PIPE DROP			
0	PIPE RISE			
——Ф——	BALL TYPE ISOLATION VALVE			
	SOIL OR WASTE PIPING			
	VENT LINE PIPING			
	DOMESTIC COLD WATER PIPING			
	DOMESTIC HOT WATER PIPING			
	HOT WATER RECIRC. PIPING			

ROOF OVERFLOW DRAIN PIPING GENERAL NOTES:

—— 6——


A- THE CONTRACTOR SHALL CHECK AND VERIFY ALL DIMENSIONS AND CONNECTIONS ON THE JOB SITE. ALL WORK SHALL BE EXECUTED FROM MEASUREMENTS TAKEN AT THE SITE.

GAS PIPING

CONDENSATE DRAIN PIPING

ROOF DRAIN PIPING

- B- THE MECHANICAL CONTRACTOR SHALL BE RESPONSIBLE TO INSURE PROPER CODE CLEARANCES FOR ELECTRICAL AND MECHANICAL ACCESS WHEN INSTALLING ANY EQUIPMENT SUPPLIED BY THE MECHANICAL CONTRACTOR.
- C- IT IS CRITICAL THAT THIS CONTRACTOR COORDINATE EQUIPMENT LOCATIONS WITH PIPING, DUCTWORK, ELECTRICAL CONDUIT AND BUILDING STRUCTURE TO INSURE CODE COMPLIANCE.
- D- CEILING DIFFUSERS ARE SHOWN IN APPROXIMATE LOCATIONS. REFER TO LIGHTING PLANS AND REFLECTED CEILING PLAN FOR EXACT LOCATIONS.
- E- DUCT DIMENSIONS CALLED OUT ON DRAWINGS ARE INSIDE FREE AREA DIMENSIONS. ACOUSTICAL DUCT LINER ARE TO BE ADDED TO OVERALL MEASUREMENTS.
- ALL DUCTWORK AND PIPING WHICH PASSES THRU FIRE RATED WALLS TO BE FIRE STOPPED WITH APPROVED FOAM OR SEALANT. REFER TO SPECIFICATIONS FOR APPROVED MANUFACTURES.
- ORIGINAL DRAWING SIGNED BY: DWAYNE C. SUDWEEKS DATE ORIGINAL SIGNED: Oct 28, 2018 ORIGINAL ON FILE AT ENGINEERED SYSTEMS ASSOCIATES 1355 EAST CENTER, POCATELLO, IDAHO 83201

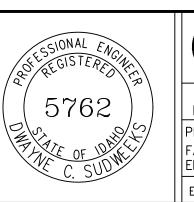

Engineered **Systems** 1355 EAST CENTER POCATELLO, IDAHO 83201

Associates PHONE: (208) 233-0501 (208) 233-0529 ||EMAIL: esa@engsystems.com ESA JOB NUMBER: 18045

DRAWN BY:

T DAVIS CHECKED BY: D SUDWEEKS DRAWING NO.

OCTOBER 2018